


### SHEET NOTE:

1. FOR EQUIPMENT TO BE DEMOLISHED: ALL EXISTING CONDUIT EXCEPT FOR COOLING TOWER AND ALL WIRING SHALL BE REMOVED. PERMISSION TO USE EXISTING CONDUIT (WIRES REMOVED) SHALL BE REQUIRED FROM WMATA ENGINEER.

### PLAN NOTE:

- (1) EXISTING CIRCUIT BREAKER TO BE REMOVED.
- 2 EXISTING MOTOR STARTER TO BE REMOVED.



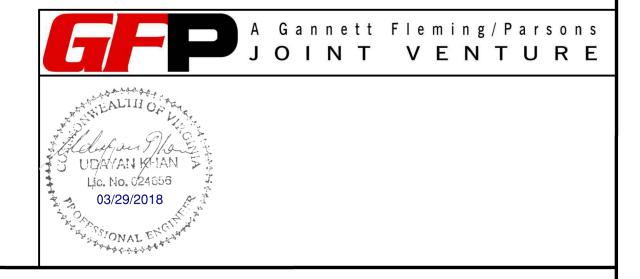


			REFERENCE DRAWINGS		REVISIONS	WASHINGTON	METROPOLI	TAN AREA TRANSIT AUTHO	RITY			REPLACEMEN	IT OF CHILLERS	
DESIGNED B. I	IDILIBI 09/30/1	NUMBER	TITLE	DATE NUM	M DESCRIPTION	metro	VILTIXOT OLI	TAN AREA TRANSIT ASTITE		ANI	COOLING TO	WER ACCESSOR	IES AT EIGHT METRO-R	AIL STATIONS
	DATE			03/30/2018 0	FINAL CONTRACT DRAWINGS	DEPARTMENT (	DE DESIGN AN	D CONSTRUCTION SERVICES		]	3 0 0 0 2 (0		ARENDON (K02)	
DRAWN J. Z	ZHU 09/30/17 DATE	_											,	ON
CHECKED D.I	KHAN 03/23/18					-1 . $1 m$		RENEWAL PROGRAM GROUP			ELECT	RICAL SINGLE LIN	IE DIAGRAM - DEMOLITI	ON
	DATE					APPROVED Mark D. IT ragnin	03/2018	APPROVED Me Alle	03/2018	M NO.	CONTRACT NO.	SCALE	DRAWING NO.	SHEET NO.
						MARK MAGNUSSEN MANAGER, ENV. PLANNING AND COMP	DATE	GRAHAM SPILLER GFP DEPUTY PROGRAM MANAGER	DATE	M1304	FQ-18102	AS NOTED	CWPK1-E-601	147 of 173

### SHEET NOTES:


1. PROVIDE NEW CIRCUIT BREAKERS WITH GROUND FAULT PROTECTION IN EXISTING MCC/SWITCHBOARD.

### PLAN NOTES:

- 1 LINE AND LOAD REACTORS FOR EACH VFD SHALL BE MOUNTED IN A SINGLE NEMA 4X ENCLOSURE
- 2 RUN NEW RGS FROM VFD'S AND STOP AT CONVENIENT PLACE NEAR MOTOR. CONTINUE WITH LTFC TO MOTOR.

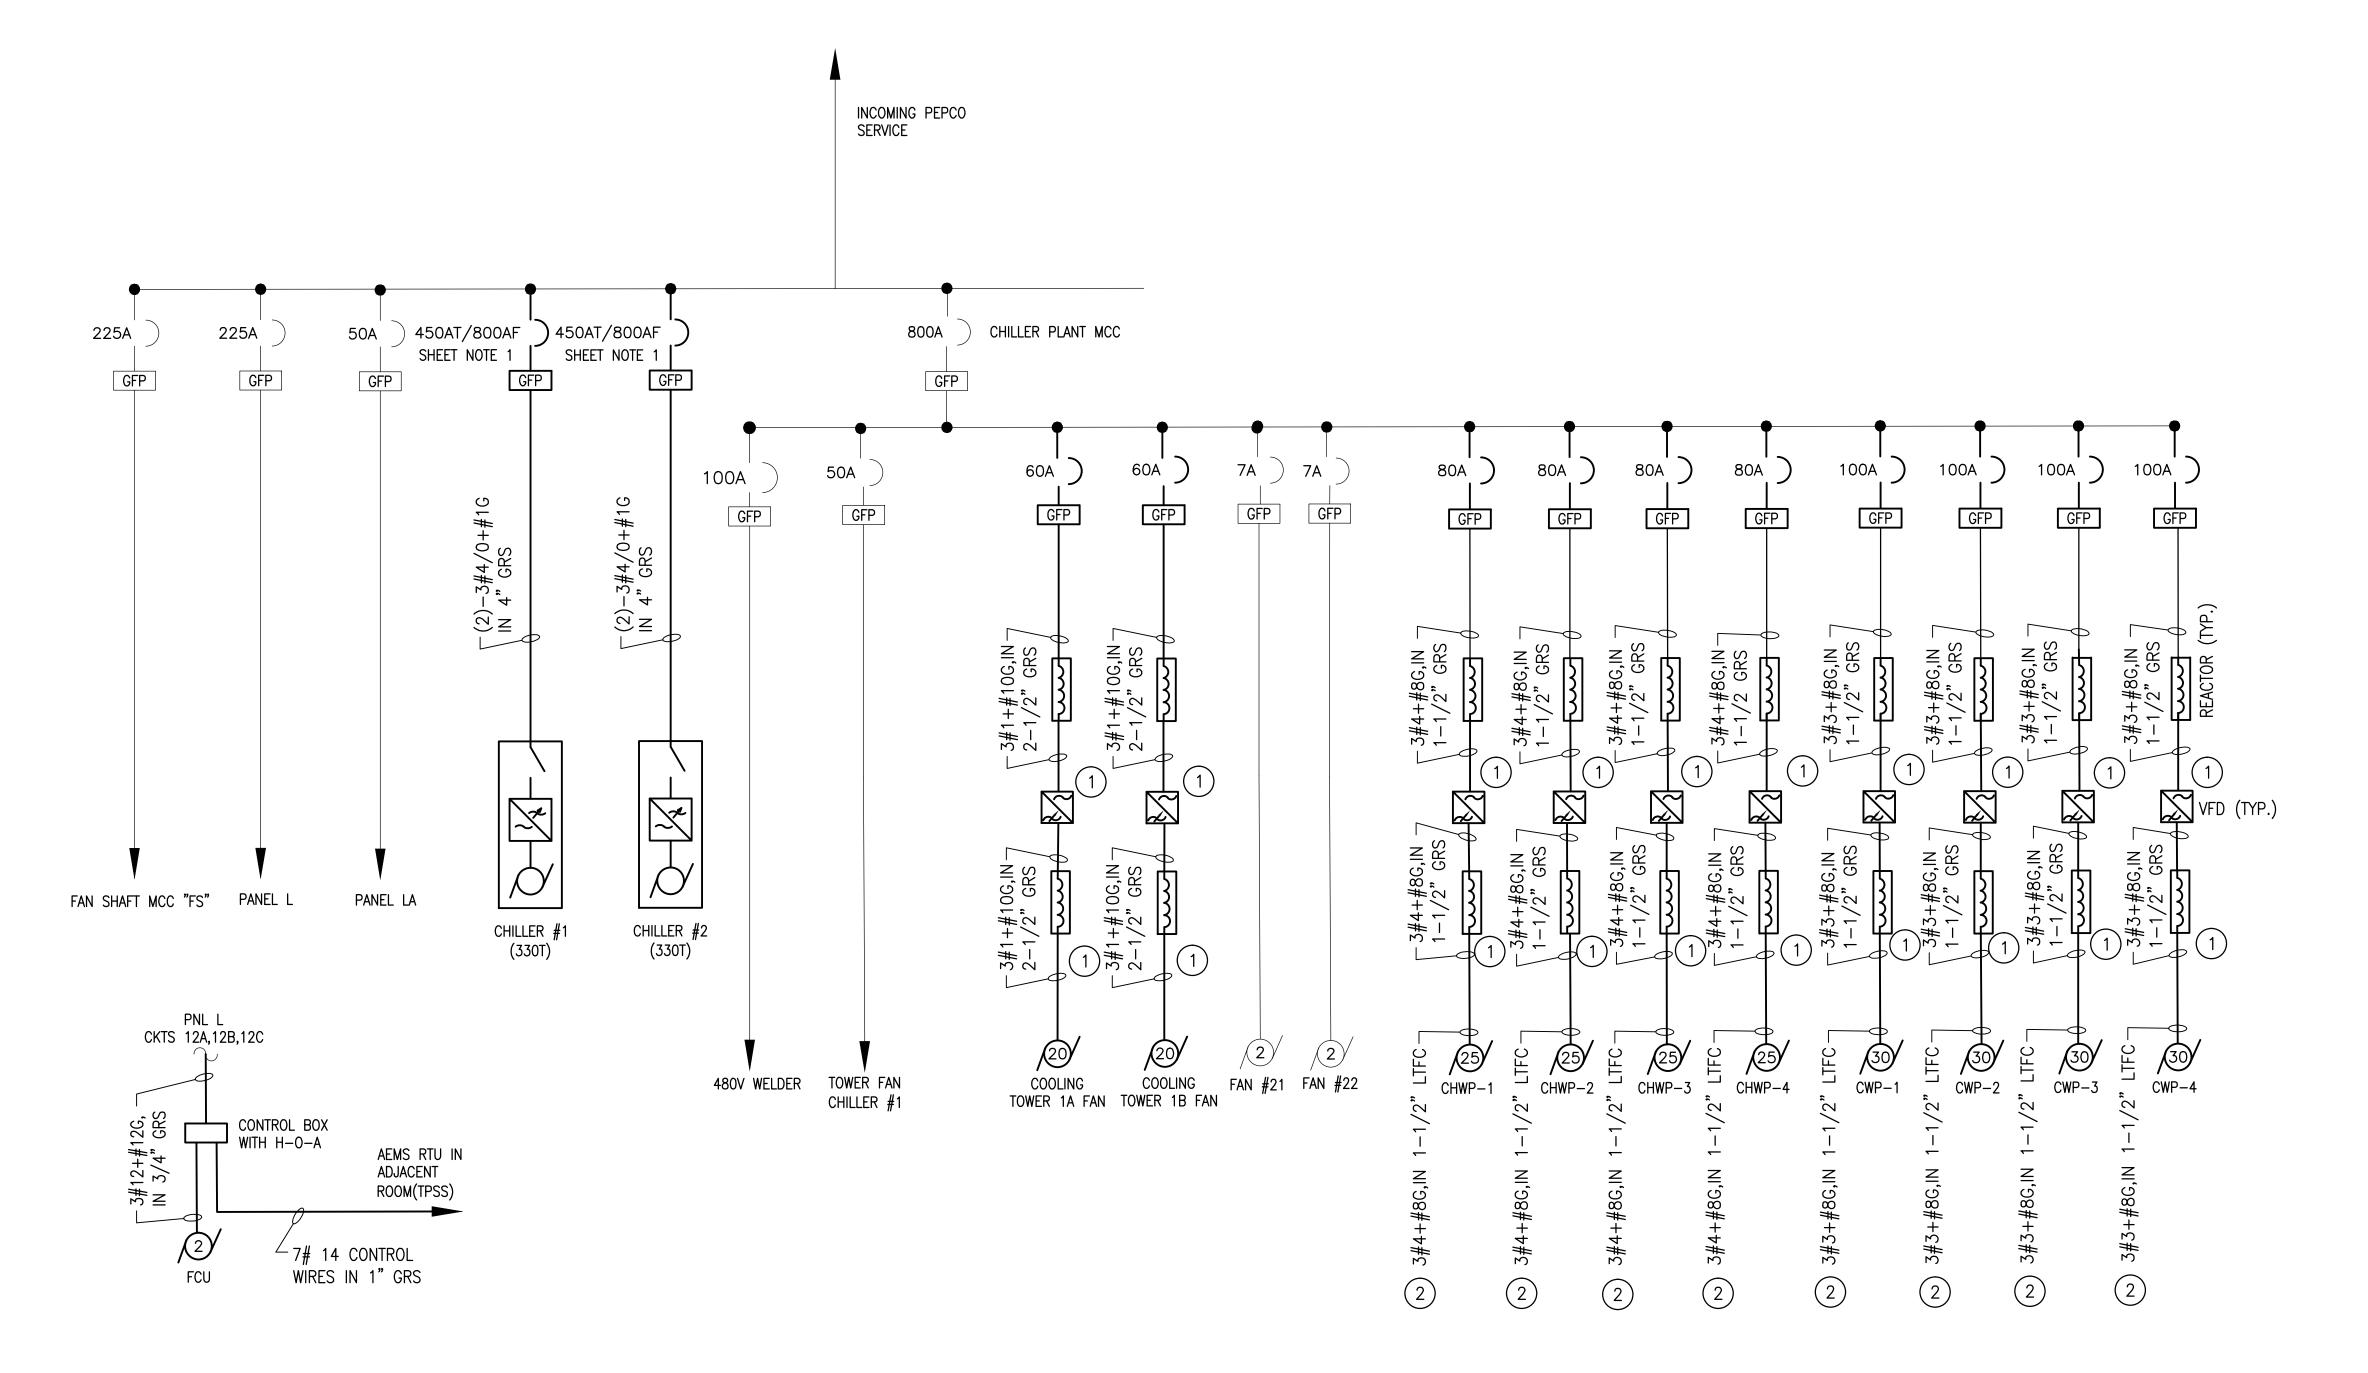

B ELECTRICAL SINGL LINE DIAGRAM - NEW WORK
CWPK1-E-602

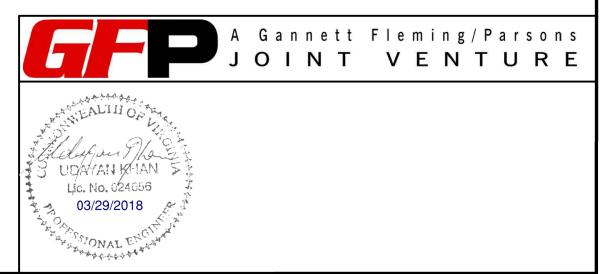

	REFERENCE DRAWINGS NUMBER TITLE	REVISIONS  DATE NUM DESCRIPTION	WASHINGTON METROPOLITAN AREA TRANSIT AUTHORITY  AND COOLING TOWER ACCESSORIES AT EIGHT METRO-RAIL STATIONS
DESIGNED B. IDILIBI 09/30/17  DATE	THE	03/30/2018 0 FINAL CONTRACT DRAWINGS	AND COOLING TOWER ACCESSORIES AT EIGHT METRO-RAIL STATIONS  DEPARTMENT OF DESIGN AND CONSTRUCTION SERVICES  CWPK1 - CLARENDON (K02)
DRAWN J. ZHU 09/30/17 DATE CHECKED D. KHAN 03/23/18			OFFICE OF INFRASTRUCTURE RENEWAL PROGRAM GROUP  ELECTRICAL SINGLE LINE DIAGRAM - NEW WORK
CHECKED D. KHAN 03/23/18 DATE			APPROVED Mark W. M. DATE  APPROVED MARK MAGNUSSEN  DATE  APPROVED MASSEN  APPROVED MASSEN
			MARK MAGNUSSEN  MANAGER, ENV. PLANNING AND COMP  GEAHAM SPILLER  GRAHAM SPILLER  M1304  FQ-18102  AS NOTED  CWPK01-E-602  148 of 173

										PA	NEL: I	_A						
MAIN BUS: 100A				MAIN	DEVI	CE: 5	0A										NEUTRA	L BUS: 100%
208/120 VOLT				3 PH	ASE.	4 W	IRE +	GROL	JND							-	RMS AIG	C: 10,000A
ENCLOSURE: NEMA 1				MOUN	ITING:	SU	RFACE										LOCATIO	N: CHILLER ROOM
LOAD	LOAD	W	IRE	RCWY	C,	/B	CKT	Pŀ	IASE K	VA	CKT	C	/B	RCWY	WIF	RE	LOAD	LOAD
DESCRIPTION	VA	СКТ	GND	SIZE	TRIP	PL	NMBR	Α	В	С	NMBR	PL	TRIP	SIZE	GND	СКТ	VA	DESCRIPTION
RECEPTS- VENT SHAFT	300	12	12	3/4"	30	1	1	1300			2	1	20	3/4"	10	10	1000	RECEPTACLES
UNIT HEATER CONTROL POWER	_	12	12	3/4"	30	1	3		600		4	1	20	3/4"	12	12	600	RECEPTACLES
RECEPTACLES	200	12	12	3/4"	20	1	5			1200	6	1	20	3/4"	12	12	1000	TCC #1 &C.M. #1
SPARE	_	_	-	<u> </u>	20	1	7	1000			8	1	20	3/4"	_	_	1000	TCC #2 &C.M. #2
RECEPTACLES	700	12	12	3/4"	20	1	9		700		10	1	20	3/4"	12	12	_	HONEYWELL CONTROLS
LIGHTS- FAN SHAFT	700	12	12	3/4"	20	1	11			700	12	1	20	_	_	_	_	SPARE
LIGHTS- FAN SHAFT	700	12	12	3/4"	20	1	13	1200			14	1	20	3/4"	12	12	500	APPAR.CONTROL PANEL
HEAT TRACE TAPE	1000	12	12	3/4"	20	1	15		1000		16	1	20	3/4"	12	12	1	AEM & RTU
HONEYWELL	_	12	12	3/4"	20	1	17			_	18	1	20	3/4"	12	12	_	SWITCHGEAR HEATER
NEUTRAL SITE GPS	_	12	12	3/4"	20	1	19	_			20	1	20	_	_	_	_	SPARE
1 CONDENSER WATER TREATMENT PACKAGE	-	12	12	3/4"	20	1	21		_		22	1	20	3/4"	12	12	-	CHILLER PLANT MONITORING PANEL
1 FLOW MONITORING PANEL	_	12	12	3/4"	20	1	23			_	24	1	20	3/4"	12	12	-	INSTANTANEOUS WATER HEATER
1 UNIT(FCU) FOR COOLING	_	12	12	3/4"	20	1	25	_			26							
CONDENSER WATER TREATMENT PACKAGE	_	12	12	3/4"	20	1	27		_		28	3	50	1¼"	10	6	-	MAIN
SPARE	_	_	-	_	20	1	29			_	30							
NOTES:																	9,812	VA
													DEMA	ND LC	AD:	9,	812VA	


		ELECTRICAL EQUIPMENT SCHEDULE
ITEM	QTY	DESCRIPTION
1	2	MCC BUCKET TO MATCH EXISTING WITH 60AT/100AF BREAKER
2	4	MCC BUCKET TO MATCH EXISTING WITH 80AT/100AF BREAKER
3	4	MCC BUCKET TO MATCH EXISTING WITH 100AT/100AF BREAKER
4	1	AC DISTRIBUTION PANEL, 100A, 208/120V AC
5	4	REACTOR/FILTER 480V, 3PH, 27A, 20HP, 60HZ, NEMA 4X ENCLOSURE
6	8	REACTOR/FILTER 480V, 3PH, 34A, 25HP, 60HZ, NEMA 4X ENCLOSURE
7	8	REACTOR/FILTER 480V, 3PH, 40A, 30HP, 60HZ, NEMA 4X ENCLOSURE
8	2	VFD,480V, 3PH, 20HP, 60HZ, NEMA 4X ENCLOSURE WITH BYPASS AND REACTOR/FILTERS
9	4	VFD,480V, 3PH, 25HP, 60HZ, NEMA 4X ENCLOSURE WITH BYPASS AND REACTOR/FILTERS
10	4	VFD,480V, 3PH, 30HP, 60HZ, NEMA 4X ENCLOSURE WITH BYPASS AND REACTOR/FILTERS
11	LOT	#1 AWG RHW-2 WIRE (VFD RATED)
12	LOT	#1 AWG RHW-2 WIRE
13	LOT	#2 AWG RHW-2 WIRE (GND)
14	LOT	#3 AWG RHW-2 WIRE (VFD RATED)
15	LOT	#3 AWG RHW-2 WIRE
16	LOT	#4 AWG RHW-2 WIRE (VFD RATED)
17	LOT	#4 AWG RHW-2 WIRE
18	LOT	#8 AWG RHW-2 WIRE (GND)
19	LOT	#10 AWG RHW-2 WIRE (GND)
20	LOT	#12 AWG RHW-2 WIRE
21	LOT	#4/0 RHW-2 WIRE
22	LOT	3/4" GRS CONDUIT
23	LOT	1" GRS CONDUIT
24	LOT	1-1/2" GRS CONDUIT
25	LOT	1-1/2" LTFC

			ENTER: 77V, 3ø,					A۱	OCATION: CHILLER PLANT /AILABLE SHORT CIRCUIT: 2 NCLOSURE TYPE: NEMA 12	28,000 AMPS RM	S SYM			
SEC.	ITEM		CIRCUIT BREAKER		MCP CONTIN.	CONNECTED LOAD	HP OR	DESCRIPTION	CONTROL DIAGRAM	ELEVATION				
NO.	NO.	POLES AMP. AMP.	RATING AMP.	KVA			DWG NO.	SECTION 1	SECTION 2	SECTION 3	SECTION 4			
	1A	3	-	-	_	_	_	MAIN LUGS						
	1B	_	_	-	_	_	_	SPACE						
1	1C	-	-	-	_	_	_	SPACE						
	1D	3	100	80	_	_	25HP	CHILLER WATER PUMP FEEDER			2A	3A	4A	
	2A	3	100	100	_	_	_	480 V WELDER		1,	ll l	3B	4B	
	2B	_	-	-	_	_	_	SPACE			2B	3C	4C	
	2C	3	100	80	_	_	25HP	CHILLER WATER PUMP FEEDER		11	200		4D	
2	2D	3	100	80	_	_	25HP	CHILLER WATER PUMP FEEDER				3D		
	2E	3	100	80	_	_	25HP	CHILLER WATER PUMP FEEDER		10		3F	4F	
	2F	_	-	-	_	_	_	SPACE		11	2E	3E	4E	
	3A	3	100	50	-	_	_	TOWER FAN CHILLER #1			2F	JE	4E	
	3B	3	100	60	_	_	20HP	COOLING TOWER 1B FAN						
	3C	3	100	60	_	_	20HP	COOLING TOWER 1A FAN						
3	3D	3	100	7	_	100	2HP	FAN #21		MANUFACTURE		-HAMMER M SERIES 2	100	
	3F	3	100	7	_	100	2HP	FAN #22			TILLDO	W JLINILJ Z	100	
	3E	_	-	-	_	_	_	SPACE						
	4A	3	100	100	_	_	30HP	CONDENSER WATER PUMP						
	4B	3	100	100	_	_	30HP	CONDENSER WATER PUMP						
	4C	3	100	100	_	_	30HP	CONDENSER WATER PUMP						
4	4D	3	100	100	_	_	30HP	CONDENSER WATER PUMP						
	4E	_	_	_	_	_	_	SPACE						
	4F	_	_	_	_	_	_	SPACE						

### SHEET NOTE:

- PROVIDE 20A SINGLE POLE, CIRCUIT BREAKER TO MATCH EXISTING AND WIRE NEW LOAD.
- 2. PROVIDE NEW, 20A, 3POLE, CIRCUIT BREAKER AND INSTALL IT IN PANEL L CKTS 12A,12B,12C. WIRE FCU CONTROL BOX TO IT.

26	LOT	2-1/2" GRS CONDUIT
27	LOT	4" GRS CONDUIT
28	2	SWBD POWER CIRCUIT BREAKER TO MATCH EXISTING 450AT/800AF

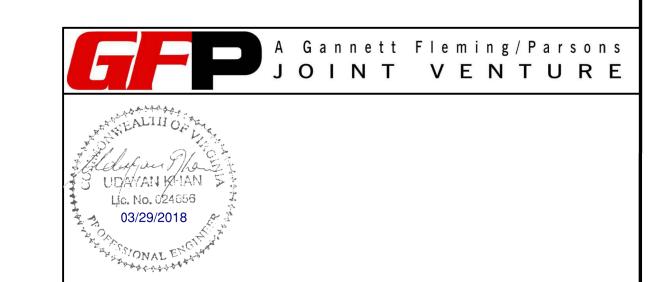

				REFERENCE DRAWINGS			REVISIONS	
	B. IDILIBI	09/30/17	NUMBER	TITLE	DATE	NUM	DESCRIPTION	II
DESIGNED	B. IDILIBI	DATE			03/30/2018	0	FINAL CONTRACT DRAWINGS	
DRAWN	J. ZHU	09/30/17						
BIOWIN		DATE						
CHECKED	D. KHAN	03/23/18						
		DATE						
								MAR

## WASHINGTON METROPOLITAN AREA TRANSIT AUTHORITY

DEPARTMENT OF DESIGN AND CONSTRUCTION SERVICES OFFICE OF INFRASTRUCTURE RENEWAL PROGRAM GROUP

OFFICE OF INFI	RASTRUCTUR	E RENEWAL PROGRAM GRO	JUP	
m 1 21 Magn	wose			$\vdash$
APPROVED I Sark A.	03/2018	APPROVED Me	03/2018	l ∿
MARK MAGNUSSEN	DATE	GRAHAM SPILLER	DATE	١,
MANAGED ENV DIANNING AND COMP		CED DEDLITY DROCDAM MANACED		''

REPLACEMENT OF CHILLERS
AND COOLING TOWER ACCESSORIES AT EIGHT METRO-RAIL STATIONS
CWPK1 - CLARENDON (K02)
ELECTRICAL EQUIPMENT AND PANEL SCHEDULE

LVVAL I NOGNAWI GNOOI			ELECTRICAL EQUIT WILINT AND TANLE SCHEDULE							
PPROVED Me Sele	03/2018	M NO.	CONTRACT NO.	SCALE	DRAWING NO.	SHEET NO.				
RAHAM SPILLER FP DEPUTY PROGRAM MANAGER	DATE	M1304	FQ-18102	AS NOTED	CWPK1-E-603	149 of 173				

### **GENERAL NOTES:**

(E) FAN CONTROL PANEL

(E) 25x8

(E) 25x8

(E) 25x14

(E) 25x8

 $_{\odot}(E)$ FD CWP-2  $\boxed{7}$ 

CWP-4

 $\searrow$  CHEMICAL TREATMENT  $\langle$  9 angle

>(E) EF#1

(E)  $1 \frac{1}{2}$  DOMESTIC

 $+cw \rightarrow$ 

(E) BACKFLOW PREVENTER


WATER SERVICE —


(E) 12" →

(E) 12" ─

- A. CONTRACTOR SHALL FIELD VERIFY EXACT LOCATION AND QUANTITIES OF EQUIPMENT, PIPING, VALVES, DUCTWORK, ELECTRICAL AND CONTROL WIRING PRIOR TO DEMOLITION. ITEMS SHOWN ON THIS PLAN ARE APPROXIMATE.
- B. REFER TO LEGEND SHEET FOR GENERAL ABBREVIATIONS AND SYMBOLS.
- KEYNOTES:
- $\langle$  1 angle REMOVE AND DISPOSE OF CHILLER, CHILLER SUPPORT, STARTER, WIRING, CONDUIT, JUNCTION AND PULL BOXES, DISCONNECT, AEMS SENSORS, AND CONTROLS. REMOVAL SHALL INCLUDE R-134a EVACUATION BY A CERTIFIED COMPANY. RECOVERED REFRIGERANT SHALL BE CLEANED AND RETURNED TO WMATA PLANT MAINTENANCE IN 125 POUND BULLET CONTAINERS.
- REMOVE AND DISPOSE OF CHILLED WATER PIPING (CHWS, CHWR), SUPPORT, TEMPERATURE AND PRESSURE GAUGES. REMOVE PIPING TO AND FROM CHILLER INCLUDING ISOLATION VALVES. EXACT DEMOLITION POINT SHALL BE FIELD COORDINATED BY CONTRACTOR TO ACCOMMODATE NEW PIPING CONNECTIONS.
- REMOVE AND DISPOSE OF CONDENSER WATER PIPING (CWR, CWS), INSULATION, TEMPERATURE AND PRESSURE GAUGES. REMOVE CONDENSER WATER SUPPLY PIPING FROM THE CHILLER UP TO AND INCLUDING THE ISOLATION VALVE. REMOVE CONDENSER WATER RETURN PIPING FROM VERTICAL ELBOW TO CHILLER. EXACT DEMOLITION POINT SHALL BE FIELD COORDINATED BY CONTRACTOR TO ACCOMMODATE NEW PIPING CONNECTIONS.
- (4) REMOVE EXISTING 1½" REFRIGERANT RELIEF (VENT) PIPING TO EXTENT SHOWN.
- REMOVE AND DISPOSE OF CHILLER CONTROL PANEL.
- REMOVE AND DISPOSE OF CHILLED WATER PUMPS CHP-1, CHP-2. CHP-3 AND CHP-4. REMOVE PIPING AND VALVES INCLUDING THE ISOLATION VALVES, STRAINERS, CHECK VALVES AND BALANCING VALVES UP TO THE PIPE CONNECTION FLANGES. REMOVAL SHALL INCLUDE PUMP, MOTOR, CONTROL AND POWER WIRING AND SPRING ISOLATORS. EXISTING INERTIA BASE AND EQUIPMENT PAD TO REMAIN.
- REMOVE AND DISPOSE OF CONDENSER WATER PUMPS CWP-1, CWP-2, CWP-3 AND CWP-4. REMOVE PIPING AND VALVES INCLUDING THE ISOLATION VALVES, STRAINERS, CHECK VALVES AND BALANCING VALVES UP TO THE PIPE CONNECTION FLANGES. REMOVAL SHALL INCLUDE PUMP, MOTOR, CONTROL AND POWER WIRING. SPRING ISOLATORS. EXISTING INERTIA BASE AND EQUIPMENT PAD TO REMAIN.
- REMOVE AND DISPOSE OF CHEMICAL POT FEEDER & ACCESSORIES FOR CHILLED WATER AND CONDENSER WATER
- 9 REMOVE AND DISPOSE OF EXISTING CONDENSER WATER TREATMENT SYSTEM (INCLUDING VALVES, PIPING, SUPPORTS, CHEMICAL DRUMS, METERING PUMPS, AND RELATED ELECTRICAL/CONTROL ACCESSORIES).
- REMOVE AND DISPOSE OF EXISTING EXPANSION TANK. TANK SUPPORT SHALL REMAIN AND BE REUSED.
- $\langle 11 \rangle$  REMOVE AND DISPOSE OF EXISTING AIR SEPRARTOR. EQUIPMENT SUPPORT SHALL REMAIN AND BE REUSED.
- (12) EXISTING REFRIGERANT MONITORING PANEL. SHOWN HERE FOR REFERENCE, COORDINATE WITH WMATA CONTRACT FQ14114.
  - REMOVE AND DISPOSE OF UNIT HEATER INCLUDING WIRING. CONDUIT, JUNCTION AND PULL BOX AND ASSOCIATED THERMOSTAT. REUSE EXISTING SUPPORT.

A Gannett Fleming/Parsons JOINT VENTURE

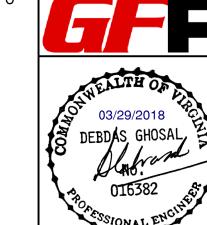

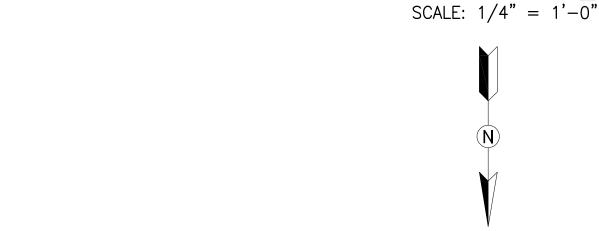

				REFERENCE DRAWINGS			REVISIONS	,
DEGLOVED	M. MCDONNELL	01/26/18	NUMBER	TITLE	DATE	NUM	DESCRIPTION	
DESIGNED	W. WODOWNELL	DATE			03/30/2018	0	FINAL CONTRACT DRAWINGS	<u> </u>
DRAWN	M. MCDONNELL	01/26/18						1
DIVAVII		DATE						1
CHECKED	D. GHOSAL	03/23/18						1
		DATE						۱,

REFRIGERANT MONITORING

 $\vdash$  (E) 6"

I 1/2" REFRIGERANT RELIEF

1 CHILLER CH-1

(E) 6" - 1 (E) 6" - 1

(E) 6" ─

CHILLER CH-2

<===>

(11) AIR SEPARATOR —

- EXPANSION TANK

 $\langle 5 \rangle$ 

- 2

(E)  $10^{\overline{"}}$ 

L\_\_\_\_J

 $\langle 3 \rangle$ 

- CHILLER CONTROL PANEL

/ (E) AIR COMPRESSOR

- (E) 30x30 UP

(E) 1 1/2"

REFRIGERANT

RELIEF UP

# WASHINGTON METROPOLITAN AREA TRANSIT AUTHORITY

(E) 25x21

(E) 48x24 GRILLE

(E) 25x10

6 CHP-3

 $CHP-2\langle 6\rangle$ 

-(E) 6"

8 POT FEEDER

 $CHP-1 \left( 6 \right) \left( 7 \right) CWP-3$ 


DEPARTMENT OF DESIGN AND CONSTRUCTION SERVICES OFFICE OF INFRASTRUCTURE RENEWAL PROGRAM GROUP

03/2018 MARK MAGNUSSEN DATE GRAHAM SPILLER GFP DEPUTY PROGRAM MANAGER MANAGER, ENV. PLANNING AND COMP

# REPLACEMENT OF CHILLERS AND COOLING TOWER ACCESSORIES AT FIGHT METRO-RAIL STATIONS

AND	CWPK2 - BALLSTON (K04)  MECHANICAL PLAN - DEMOLITION										
M NO.	CONTRACT NO.	SCALE	DRAWING NO.	SHEET NO.							
M1304	FQ-18102	1/4" = 1'-0"	CWPK2-M-100	150 of 173							

MECHANICAL FLOOR PLAN - DEMOLITION CWPK2-M-100

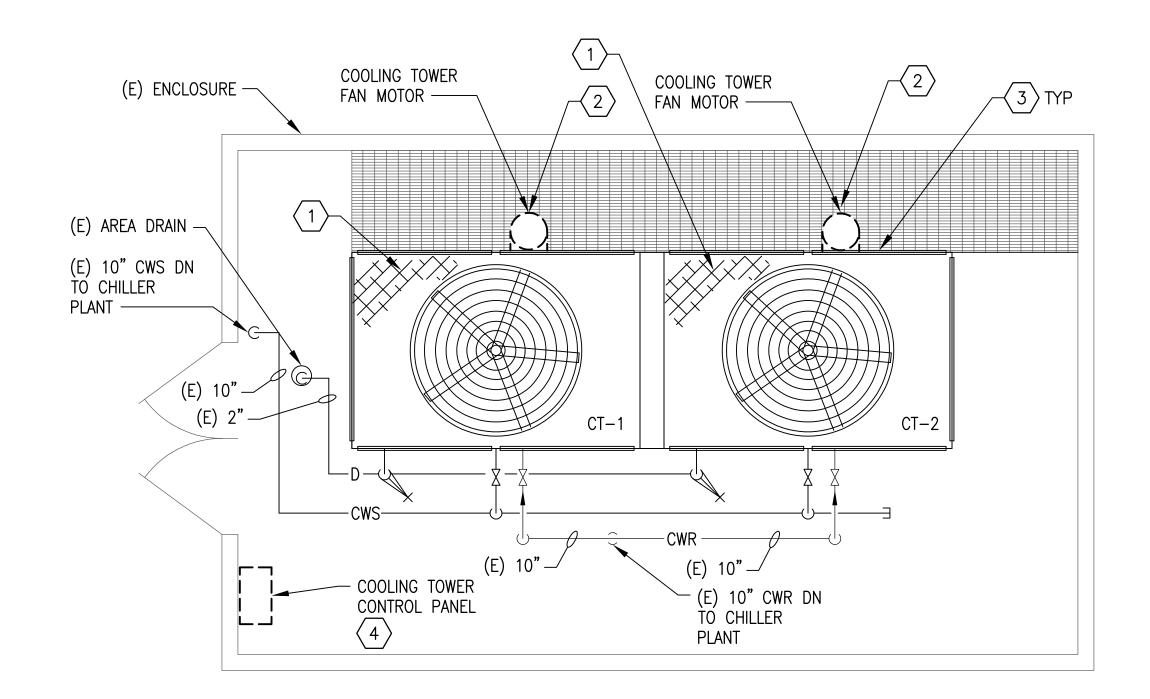

MECHANICAL PLAN - DEMOLITION CWPK2-M-101


SCALE: 1/4" = 1'-0"


### GENERAL NOTES:

- A. CONTRACTOR SHALL FIELD VERIFY EXACT LOCATION AND QUANTITIES OF EQUIPMENT, PIPING, VALVES, DUCTWORK, ELECTRICAL AND CONTROL WIRING PRIOR TO DEMOLITION. ITEMS SHOWN ON THIS PLAN ARE APPROXIMATE.
- B. REFER TO LEGEND SHEET FOR GENERAL ABBREVIATIONS AND SYMBOLS.
- C. ALL COOLING TOWER COMPONENTS THAT ARE REMOVED ARE TO BE REPLACED IN KIND. INSTALLING CONTRACTOR SHALL COORDINATE WITH COOLING TOWER MANUFACTURER PRIOR TO REMOVAL.

### KEYNOTES:

- 1 REMOVE AND DISPOSE OF EXISTING COOLING TOWER FILL.
- 2 REMOVE EXISTING FAN MOTOR, BELT DRIVEN FAN DRIVE ASSEMBLY, BELTS, SHEAVES AND MOUNTING HARDWARE.
- 3 REMOVE AND DISPOSE OF EXISTING LOUVER.
  4 REMOVE DISCONNECT AND CONTROLS.

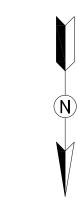

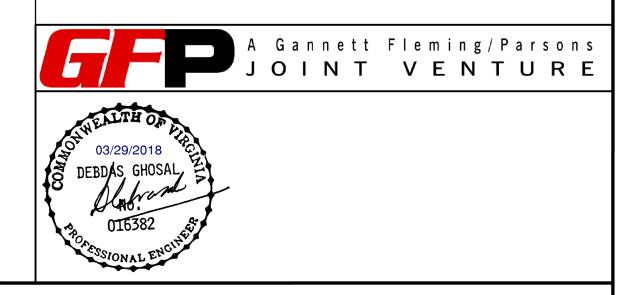

				REFERENCE DRAWINGS		REVISIONS			
	DESIGNED	M. MCDONNELL	01/26/18	NUMBER	TITLE	DATE	NUM	DESCRIPTION	_ ;
			DATE	1		03/30/2018	3 0	FINAL CONTRACT DRAWINGS	blue
	DRAWN	M. MCDONNELL 01/26/18		'					
			DATE	1			<u> </u>		_
	CHECKED L	D. GHOSAL	03/23/18	'			<u> </u>		_
ı			DATE	'					_  /
			Ì	<b>'</b>		1			1 -

# WASHINGTON METROPOLITAN AREA TRANSIT AUTHORITY

DEPARTMENT OF DESIGN AND CONSTRUCTION SERVICES OFFICE OF INFRASTRUCTURE RENEWAL PROGRAM GROUP

MANAGER, ENV. PLANNING AND COMP

03/2018 GRAHAM SPILLER M1304 GFP DEPUTY PROGRAM MANAGER

REPLACEMENT OF CHILLERS AND COOLING TOWER ACCESSORIES AT EIGHT METRO-RAIL STATIONS CWPK2 - BALLSTON (K04)

	N	MECHANICAL PLA	AN - DEMOLITIC
1 NO.	CONTRACT NO.	SCALE	DRAWING NO.
<i>I</i> 1304	FQ-18102	1/4" = 1'-0"	CWPK2-M-101

SHEET NO. CWPK2-M-101 151 of 173

### **GENERAL NOTES:**


- CONTRACTOR SHALL FIELD VERIFY AND COORDINATE LOCATION OF NEW EQUIPMENT, PIPING, VALVES, DUCTWORK, ELECTRICAL AND CONTROL WIRING WITH EXISTING PRIOR TO INSTALLATION. ITEMS SHOWN ON THIS PLAN ARE APPROXIMATE.
- B. REFER TO LEGEND SHEET FOR GENERAL ABBREVIATIONS AND SYMBOLS.
- C. REFER TO CHILLER PIPING SCHEMATIC FOR ALL VALVES. FOR CLARITY, ALL VALVES ARE NOT SHOWN ON THIS PLAN.
- D. INSTALL ALL EQUIPMENT AND COMPONENTS PER MANUFACTURER'S RECOMMENDATION WITH CLEARANCE FOR MAINTENANCE AND OPERATION OF EQUIPMENT. PROVIDE ACCESS CLEARANCE AT ALL LOCATIONS OF VALVES, STRAINERS, INSTRUMENTATION, AND EQUIPMENT AS REQUIRED BY MANUFACTURER FOR EASE OF MAINTENANCE.

#### **KEYNOTES**:

- (1) PROVIDE AND INSTALL CHILLER, CORRESPONDING VIBRATION ISOLATION, ANCHOR AND SUPPORT.
- (2) PROVIDE AND INSTALL ALL PIPING, FITTINGS, VALVES, PIPING INSULATION AND INSTRUMENTATION FOR CONNECTION TO CHILLER. PROVIDE A VICTAULIC COUPLING CONNECTION PIECE AT EACH PIPE CONNECTION TO CHILLER FOR EASE OF MAINTENANCE.
- (3) REUSE EXISTING EQUIPMENT PAD. REPAIR AND MODIFY AS REQUIRED TO FIT NEW INSTALLATION.
- (4) PROVIDE AND INSTALL CHILLED WATER PUMPS, CHWP-1. CHWP-2, CHWP-3 AND CHWP-4. INSTALLATION SHALL INCLUDE PUMP, INVERTER DUTY RATED MOTOR FOR VFD APPLICATION, VIBRATION SUPPORT, PIPING, ISOLATION VALVES, TRIPLE DUCT VALVES, STRAINER/SUCTION DIFFUSER, FLEXIBLE CONNECTORS, ECCENTRIC REDUCERS AND CORRESPONDING INSTRUMENTATION & CONTROLS. INSULATE PUMPS AND PIPING.
- (5) PROVIDE AND INSTALL CONDENSER WATER PUMPS, CWP-1, CWP-2, CWP-3 CWP-4. INSTALLATION SHALL INCLUDE PUMP, INVERTER DUTY RATED MOTOR FOR VFD APPLICATION, VIBRATION SUPPORT, PIPING, ISOLATION VALVES, TRIPLE DUTY VALVES, STRAINER/SUCTION DIFFUSER, FLEXIBLE CONNECTORS, ECCENTRIC REDUCERS AND CORRESPONDING INSTRUMENTATION & CONTROLS. INSULATE PUMPS AND PIPING.
- (6) INTEGRATE PUMP VFD DRIVES WITH CHILLER CONTROL PANEL. REFER TO ELECTRICAL DRAWINGS FOR EXACT LOCATION OF VFD's.
- (7) PROVIDE AND INSTALL AIR SEPARATOR, CORRESPONDING PIPING AND SUPPORTS. INSULATE AIR SEPARATOR AND
- (8) PROVIDE AND INSTALL EXPANSION TANK AND CORRESPONDING PIPING. REUSE EXISTING SUPPORT.

- (9) CONTRACTOR SHALL PAINT CHILLER PLANT FLOORS AND EQUIPMENT PADS WITH BATTLE SHIP GREY OR EQUAL. THE SAFETY LINES AND TRIPPING HAZARD SHALL BE PAINTED YELLOW OR RED.
- (10) A. COORDINATE WITH OTHER WMATA CONTRACT INSTALLING WATER TREATMENT SYSTEM.
  - B. PROVIDE AND INSTALL A NEW WMATA CHILLED WATER SYSTEM LOOP. THE LOOP SHALL INCLUDE PIPING, VALVES, HACH INDUCTIVE CONDUCTIVITY SENSOR - 3725E2T, FLOW SWITCH GEM SENSORS FS-500 170231, AND CONVERTIBLE DIGITAL PH SENSOR HACH DPC1R2A. REFER TO REFERENCE DRAWING DD-ME-HVAC-007.
- C. PROVIDE AND INSTALL A NEW WMATA CONDENSER WATER SYSTEM LOOP. THE LOOP SHALL INCLUDE PIPING, VALVES, HACH INDUCTIVE CONDUCTIVITY SENSOR - 3725E2T, FLOW SWITCH GEM SENSORS FS-500 170231. REFER TO REFERENCE DRAWING DD-ME-HVAC-008.

- (11) PROVIDE AND INSTALL CHEMICAL POT FEEDING FOR CONDENSER WATER AND CHILLED WATER SYSTEM. FEEDING POT SHALL BE NEPTUNE VTF-5HF.
- (12) PROVIDE AND INSTALL ONE CHILLER PLANT CONTROL PANEL (CPCP). REFER TO REFERENCE DRAWINGS DD-ME-HVAC-009 FOR CPCP DETAILS. PANEL SHALL BE INSTALLED 48" ABOVE FINISHED FLOOR.
- (13) PROVIDE AND INSTALL CHILLED WATER AND CONDENSER WATER FLOW MONITORING SYSTEM. PROVIDE AND INSTALL COMMUNICATIONS WIRING IN RIGID CONDUIT FROM FLOW MONITORING PANEL TO CHILLER PLANT CONTROL PANEL. UTILIZING BELDEN 89842 MULTI-CONDUCTOR; LOW CAPACITANCE COMPUTER TO COMPUTER POINT OF SERVICE (POS) CABLE OR EQUIVALENT. INSTALL 48" ABOVE FINISHED FLOOR.
- (14) PROVIDE AND INSTALL REFRIGERANT VENT/RELIEF PIPING FROM CHILLER (AS PER MANUFACTURER'S INSTRUCTIONS). FIELD VERIFY AND CONNECT NEW 2" REFRIGERANT RELIEF PIPING FROM CHILLER TO EXISTING REFRIGERANT RELIEF MAIN.

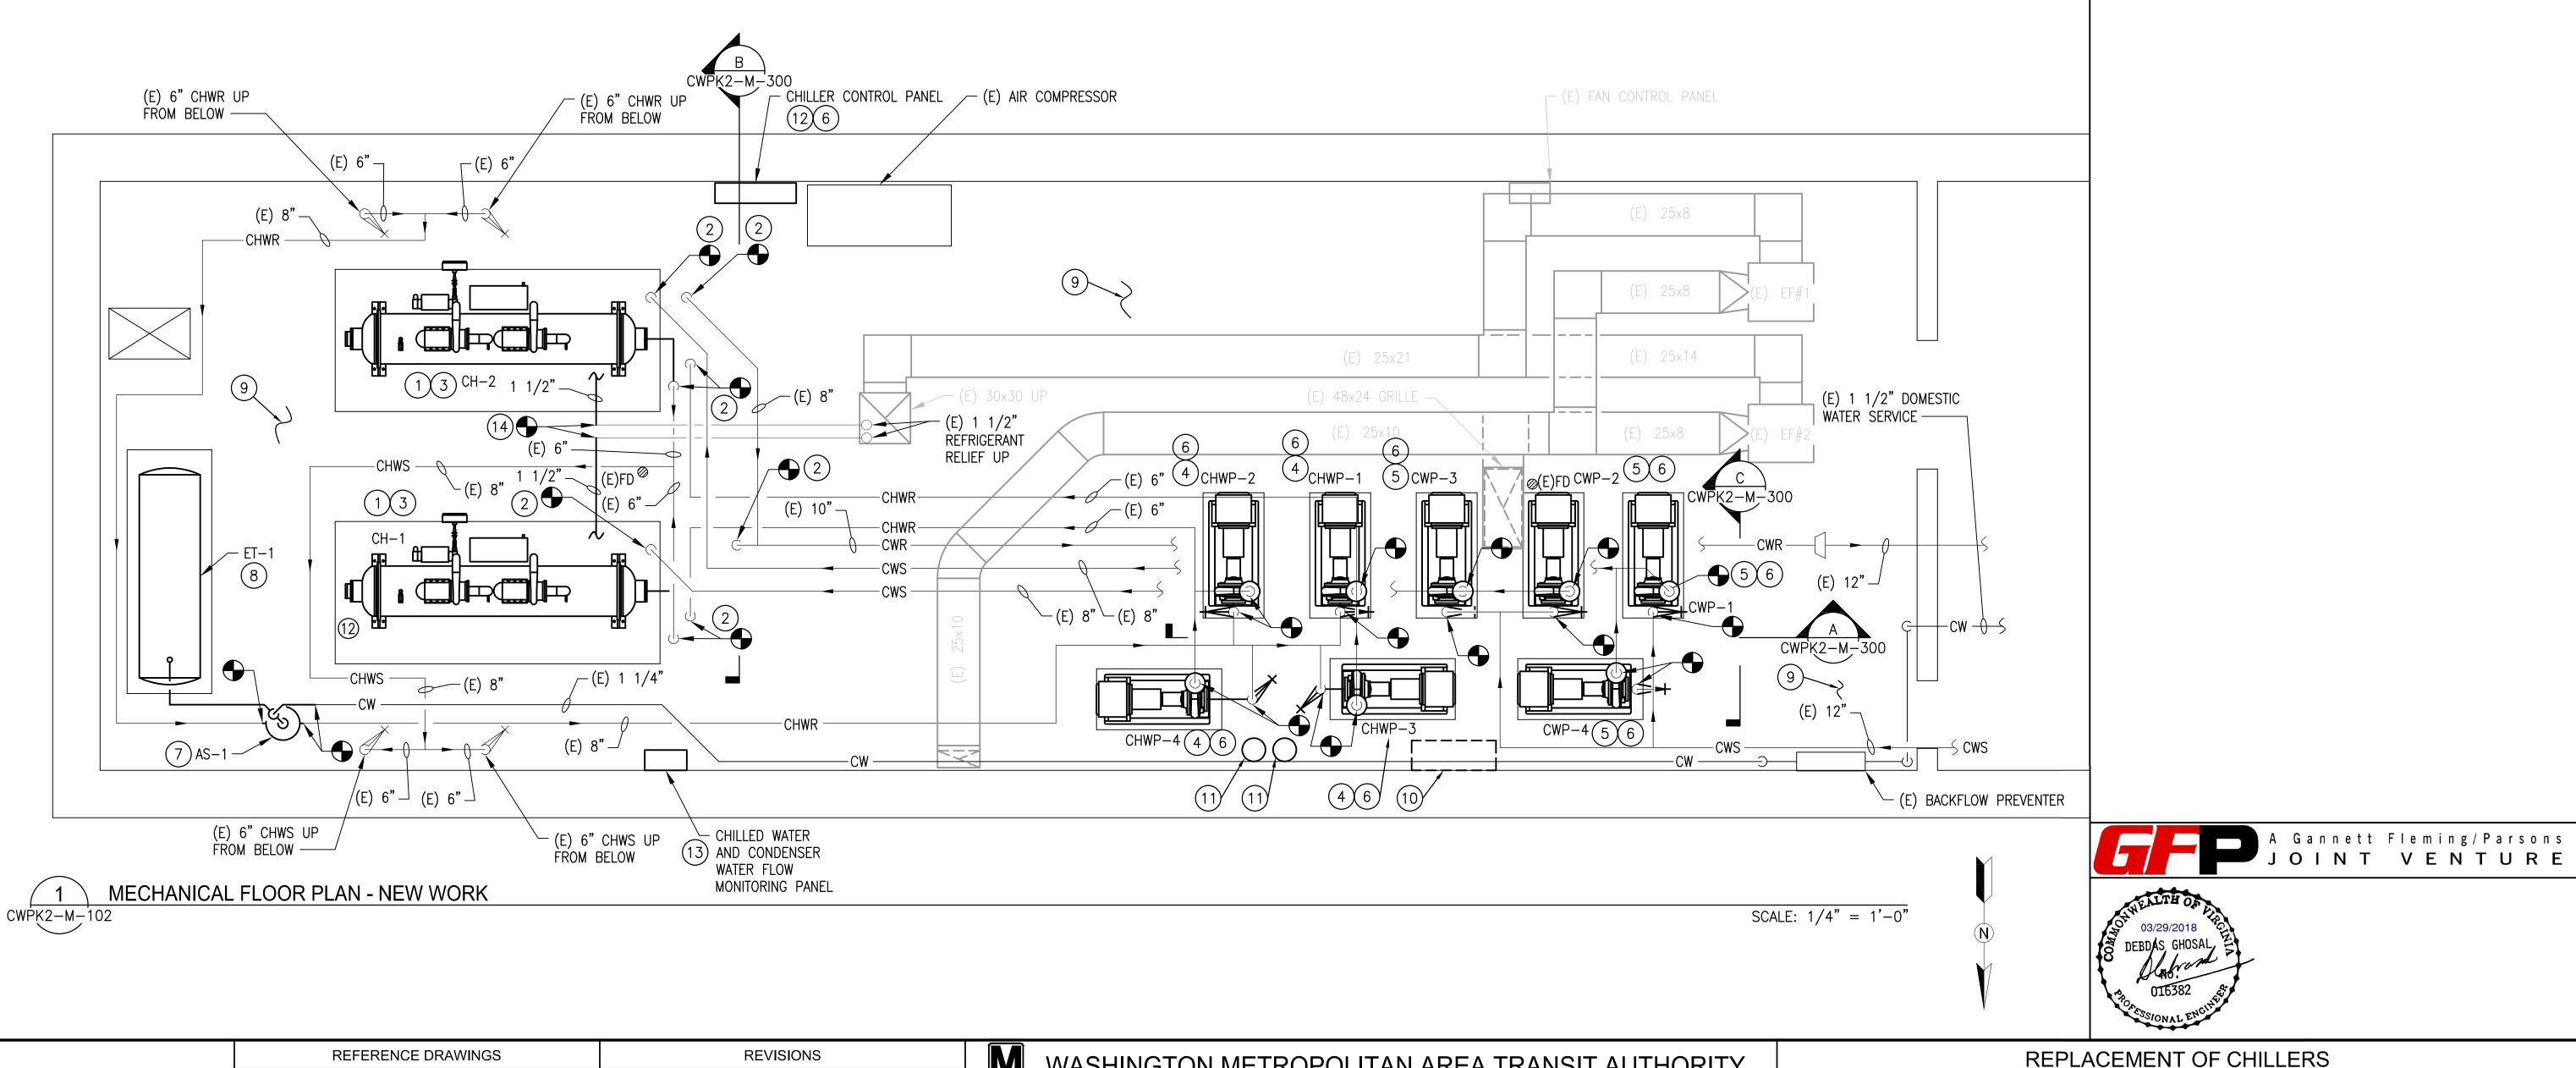

DESCRIPTION DATE NUM DESIGNED M. MCDONNELL 01/26/18 03/30/2018 0 FINAL CONTRACT DRAWINGS M. MCDONNELL 01/26/18 CHECKED D. GHOSAL 03/23/18
DATE

### WASHINGTON METROPOLITAN AREA TRANSIT AUTHORITY

DEPARTMENT OF DESIGN AND CONSTRUCTION SERVICES OFFICE OF INFRASTRUCTURE RENEWAL PROGRAM GROUP

03/2018 DATE GRAHAM SPILLER GFP DEPUTY PROGRAM MANAGER MANAGER, ENV. PLANNING AND COMP

AND COOLING TOWER ACCESSORIES AT EIGHT METRO-RAIL STATIONS CWPK2 - BALLSTON (K04) **MECHANICAL PLAN - NEW WORK** 

M NO. CONTRACT NO. SCALE DRAWING NO. SHEET NO. M1304 1/4" = 1'-0" FQ-18102 CWPK2-M-102 152 of 173